



FIGURES

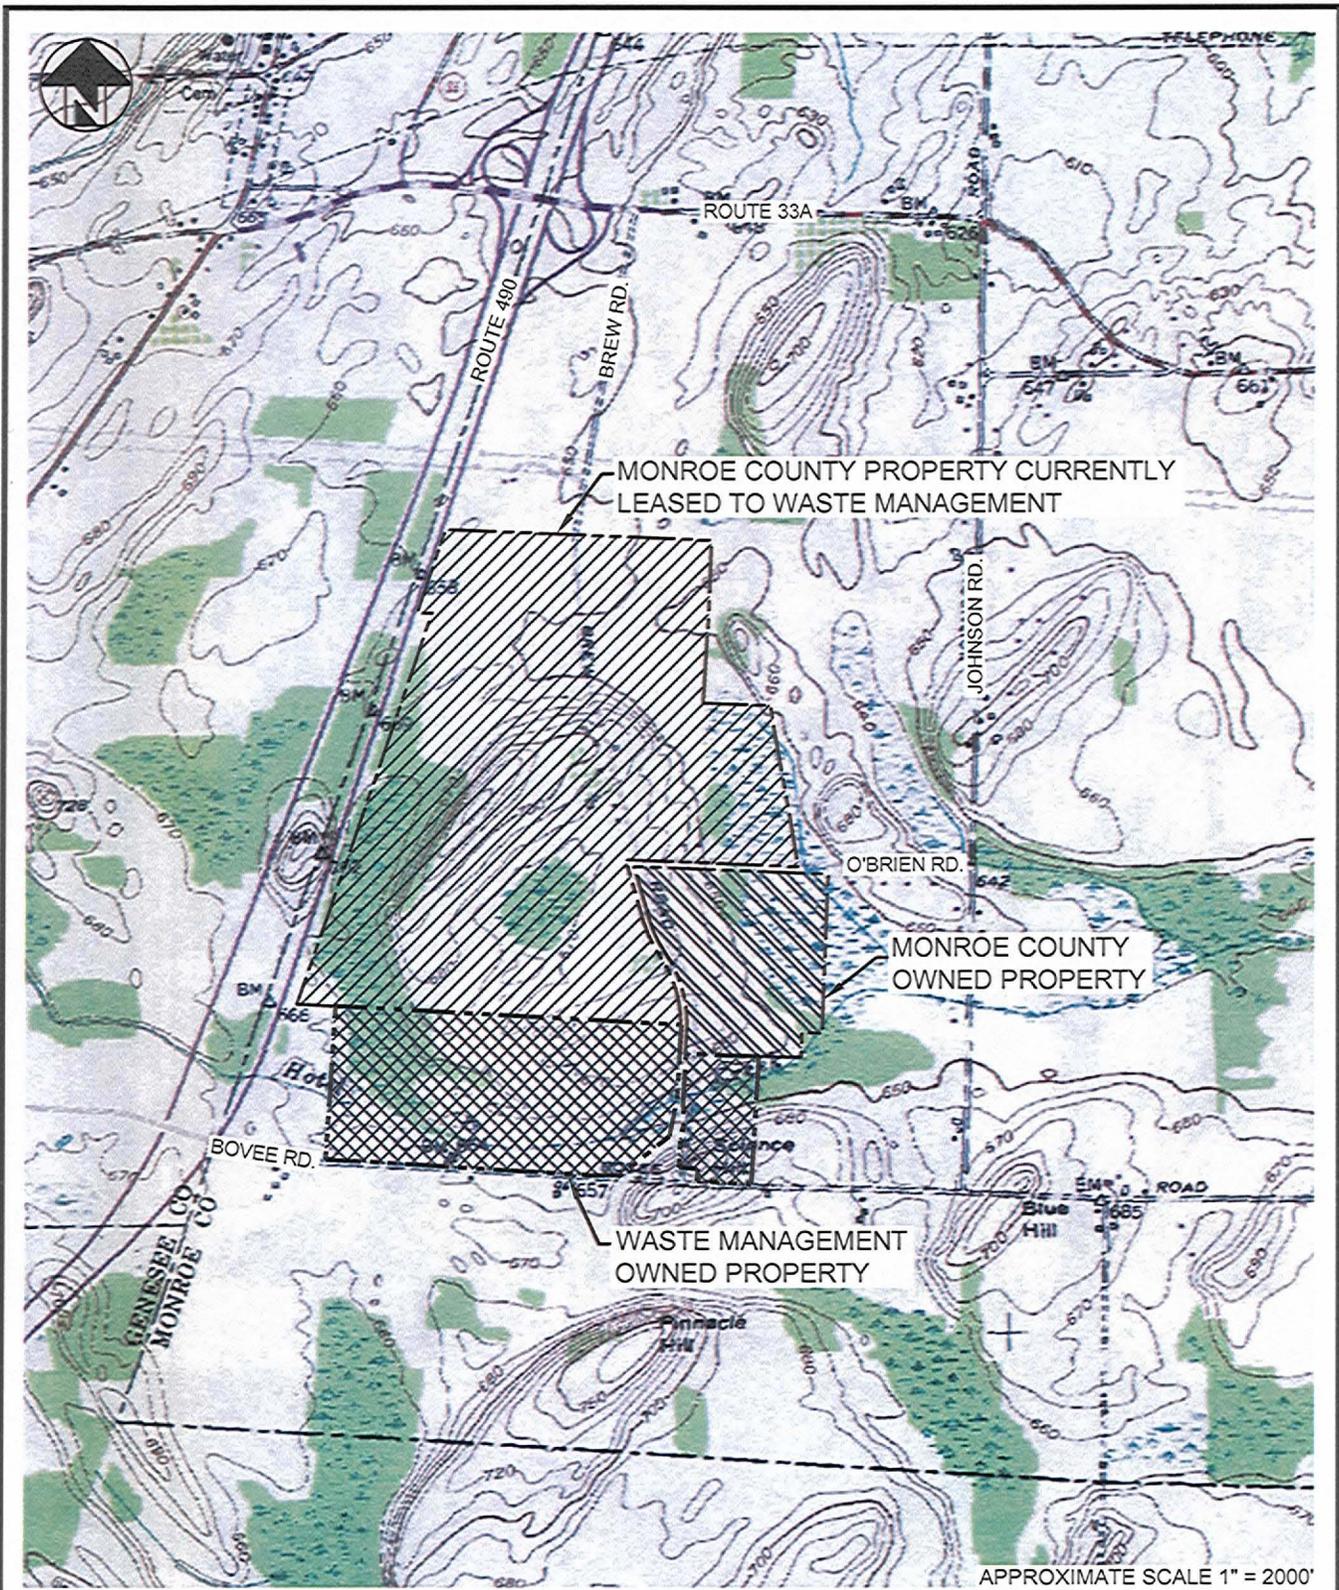

NOTE:

1. Base map adapted from 7.5 minute series USGS map of Churchville, NY dated 1950 and photorevised 1978.

McMahon & Mann Consulting Engineers, P.C. <small>2495 MAIN STREET, SUITE 432 BUFFALO, NY 14214</small>	MILL SEAT FACILITY PROPOSED SOIL BORROW AREA DSEIS MONROE COUNTY NEW YORK	SITE LOCATION PLAN
		DWG. NO.08015-019a
		FIGURE 1-1

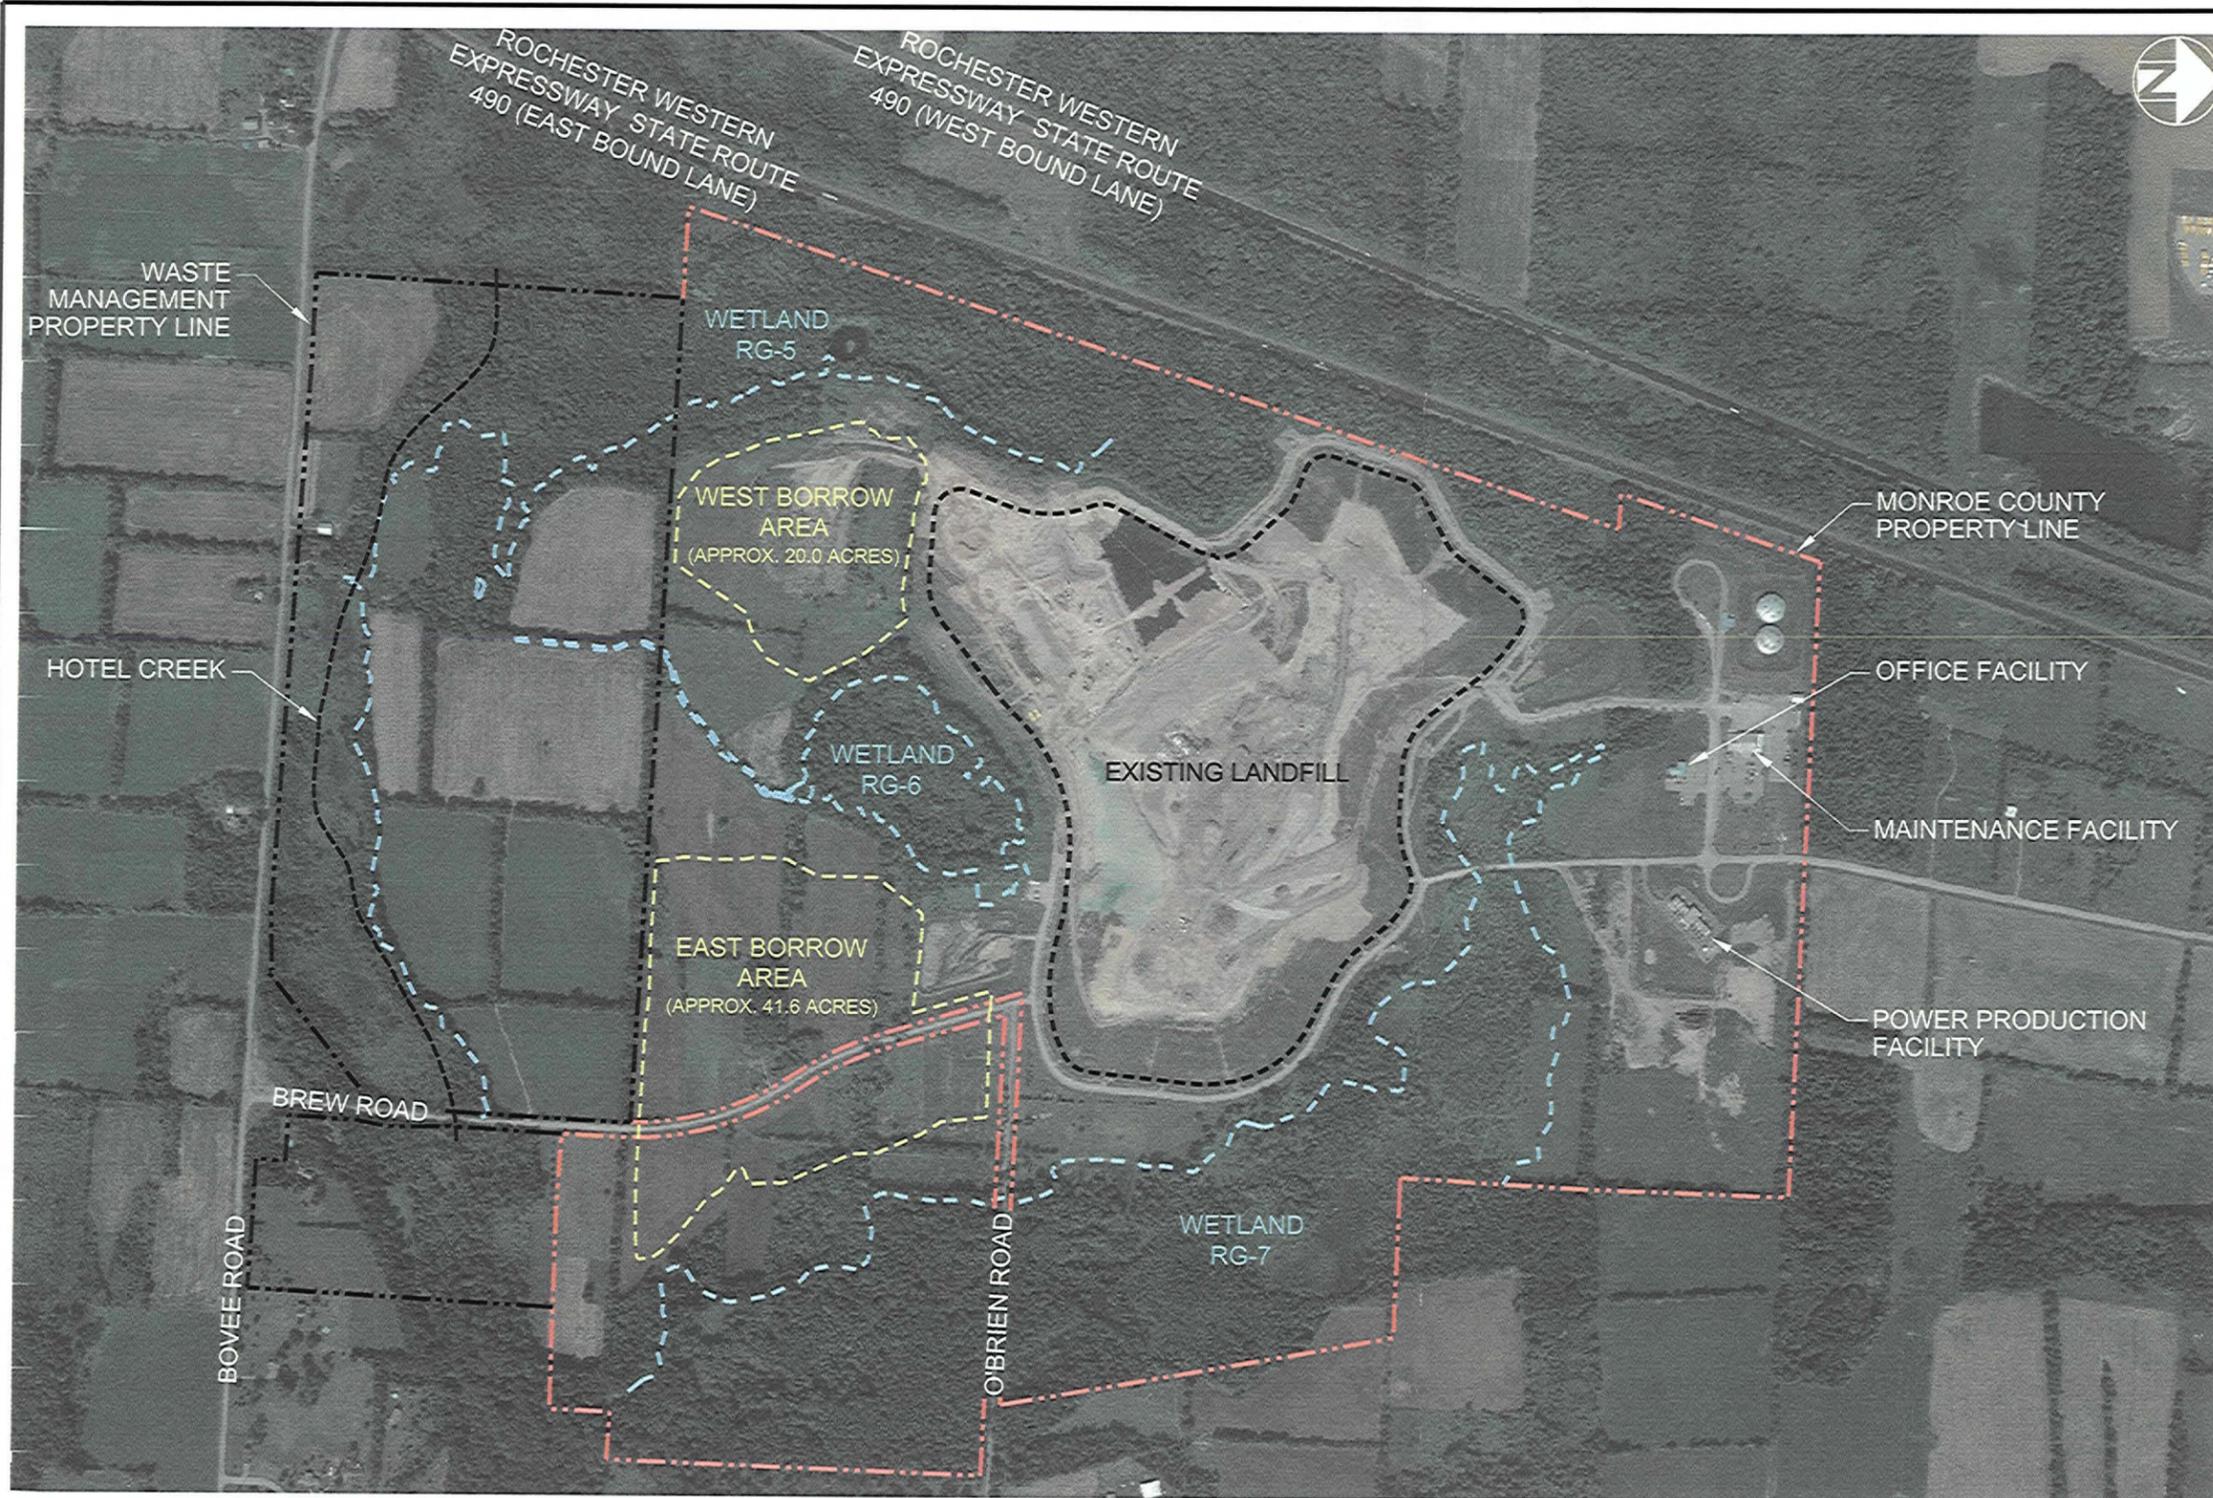

LEGEND	
	EXISTING LANDFILL LIMITS
	PROPOSED BORROW AREA LIMITS
	MONROE COUNTY PROPERTY LINE (SEE NOTE 2)
	WASTE MANAGEMENT PROPERTY LINE (SEE NOTE 2)
	DELINEATED WETLAND LIMITS (SEE NOTE 3)

- NOTES:
1. Base map image provided by Aero-Metric from aerial photography dated July 2, 2008.
 2. Property lines were provided by Golder Associates from drawing file X07386309A-Property Line and by Passero Associates from drawing file 200765103bsBovee.
 3. Wetland boundaries and buffers are based on Barton & Loguidice, P.C. Wetland Delineation Map dated August 12, 2009.




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BUFFALO, NY 14214 FAX: (716) 834-8934

MILL SEAT FACILITY
PROPOSED SOIL BORROW AREA
DSEIS
MONROE COUNTY NEW YORK

PROJECT LOCATION PLAN	
DWG. NO. 08015-029c	FIGURE 1-2

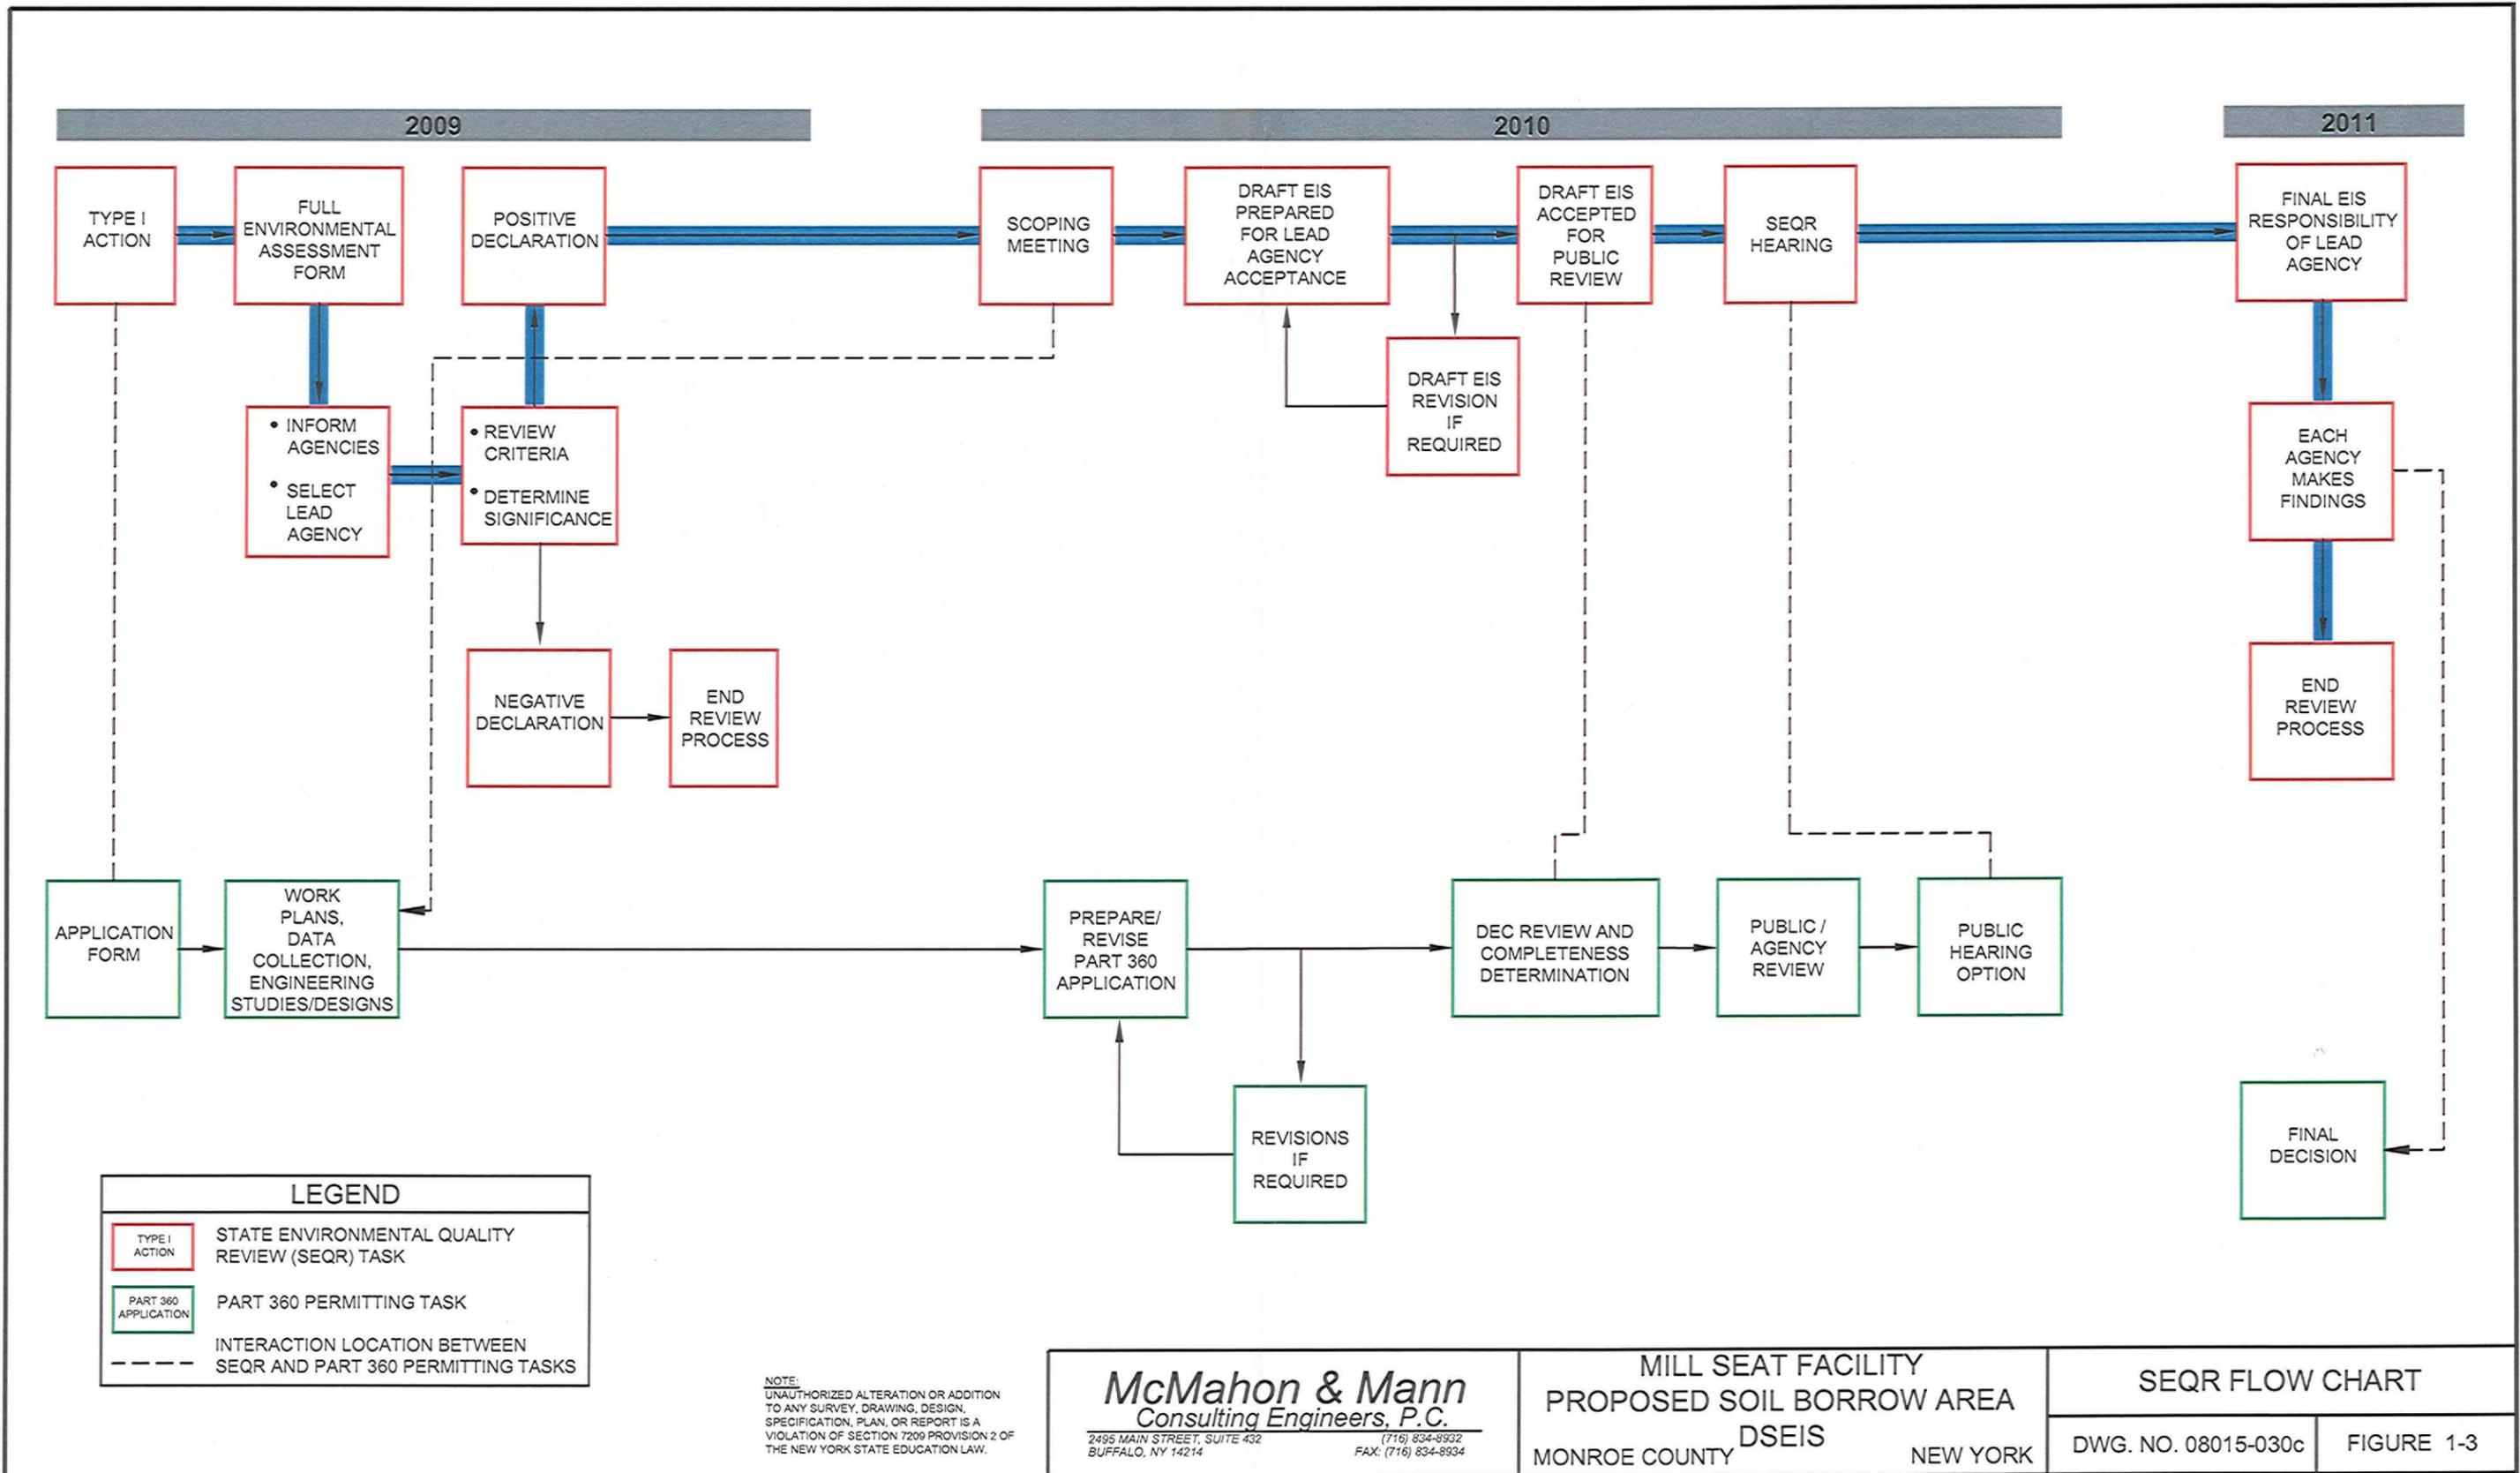


McMahon & Mann
Consulting Engineers, P.C.

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 BUFFALO, NY 14214 FAX: (716) 834-8934

MILL SEAT FACILITY
 PROPOSED SOIL BORROW AREA
 DSEIS
 MONROE COUNTY NEW YORK

SEQR FLOW CHART

DWG. NO. 08015-030c FIGURE 1-3


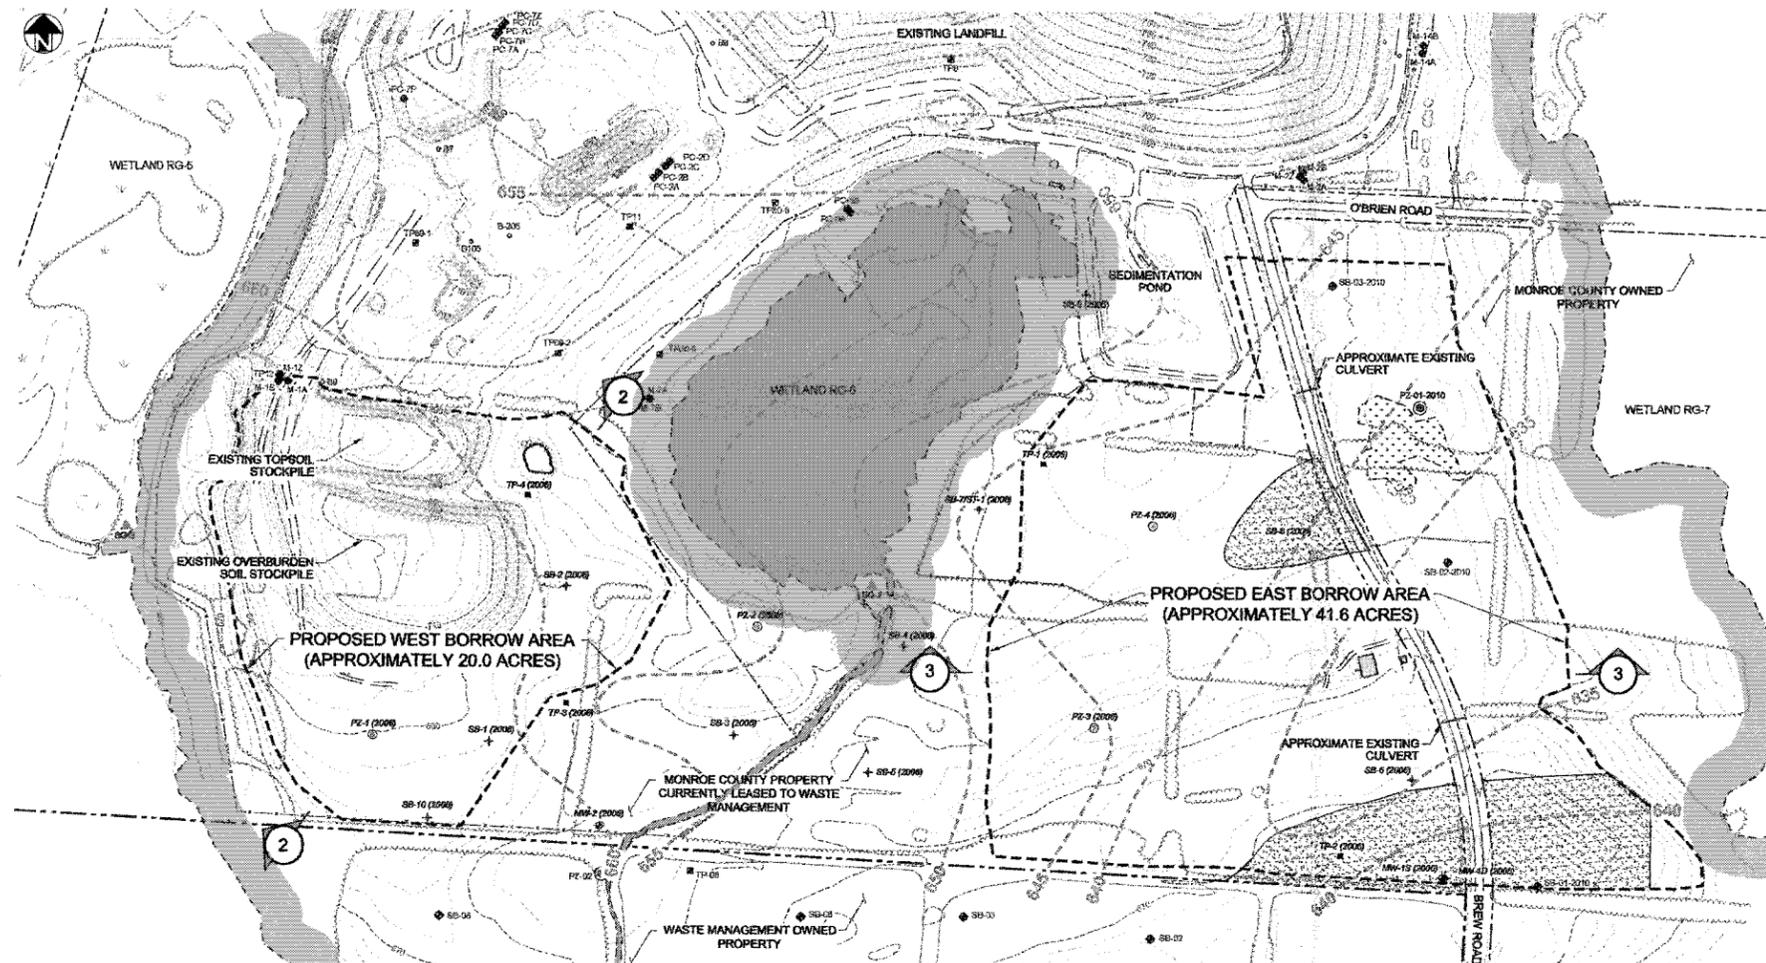


LEGEND	
---	EXISTING GROUND CONTOURS (SEE NOTE 1)
---	EXISTING ROAD
---	WASTE MANAGEMENT PROPERTY LINE (SEE NOTE 2)
---	MONROE COUNTY PROPERTY LINE (SEE NOTE 2)
---	EXISTING TREE LINE
---	EXISTING FENCE LINE
---	EXISTING WATER BOUNDARY
---	PROPOSED BORROW AREA LIMITS
---	LANDFILL STAGE LIMITS
---	100' WETLAND BUFFER (SEE NOTE 3)
---	DELINEATED WETLANDS (SEE NOTE 3)
---	NON JURISDICTIONAL DELINEATED WETLAND (SEE NOTE 3)
TP-1 (2008)	TEST PIT LOCATION AND DESIGNATION (SEE NOTE 4)
SB-1 (2008)	TEST BORING LOCATION AND DESIGNATION (SEE NOTE 4)
MW-1 (2008)	MONITORING WELL LOCATION AND DESIGNATION (SEE NOTE 4)
PZ-1 (2008)	PIEZOMETER LOCATION AND DESIGNATION (SEE NOTE 4)
SB-9 (2008)	2006 SOIL BORING LOCATION AND DESIGNATION (SEE NOTE 4)
MW-2 (2008)	2006 GROUNDWATER MONITORING WELL LOCATION AND DESIGNATION (SEE NOTE 4)
TP-1 (2008)	2006 TEST PIT LOCATION AND DESIGNATION (SEE NOTE 4)
PZ-4 (2008)	2006 PIEZOMETER LOCATION AND DESIGNATION (SEE NOTE 4)
PZ-01	2008 PIEZOMETER LOCATION AND DESIGNATION (SEE NOTE 4)
SG-4	STAFF GAUGE LOCATION AND DESIGNATION (SEE NOTE 4)
SB-08	2008 SOIL BORING LOCATION AND DESIGNATION (SEE NOTE 4)
SB-03-2010	2010 SOIL BORING LOCATION AND DESIGNATION (SEE NOTE 4)
PZ-01-2010	2010 PIEZOMETER LOCATION AND DESIGNATION (SEE NOTE 4)
-6.40	APPROXIMATE BEDROCK CONTOUR (SEE NOTE 6)
○	APPROXIMATE LOCATION OF SAND AND GRAVEL DEPOSITS (SEE NOTE 7)
EL. 670.04	APRIL 2008 WATER LEVEL (SEE NOTE 8)


NOTES:

- Existing site topography and features are based on aerial photography dated July 2, 2008 compiled by Aero-Metric.
- Property lines were provided by Golder Associates from drawing file X07386309A-Property Line and by Passero Associates from drawing file 200765103beBovee.
- Wetland boundaries and buffers are based on Barton & Loguidice, P.C. Wetland Delineation Map dated August 12, 2008.
- Test pit, boring, piezometer, groundwater monitoring well and staff gauge locations are based on information presented on Figure 3 of the Hydrogeologic Investigation Report prepared by AMEC Geomatrix dated January 2011.
- Approximate bottom of existing stockpiles provided by Golder Associates.
- Approximate bedrock contours and surfaces are as shown on Figure 11 of the Hydrogeologic Investigation Report prepared by AMEC Geomatrix dated January 2011.
- Approximate location of the sand and gravel deposits are based on information presented on Figure 10 of the Hydrogeologic Investigation Report prepared by AMEC Geomatrix dated January 2011.
- April 2008 groundwater information is based on groundwater elevations presented in Table 2 of the Hydrogeologic Investigation Report prepared by AMEC Geomatrix dated January 2011.

1 EXISTING CONDITIONS PLAN
SCALE: 1" = 200'

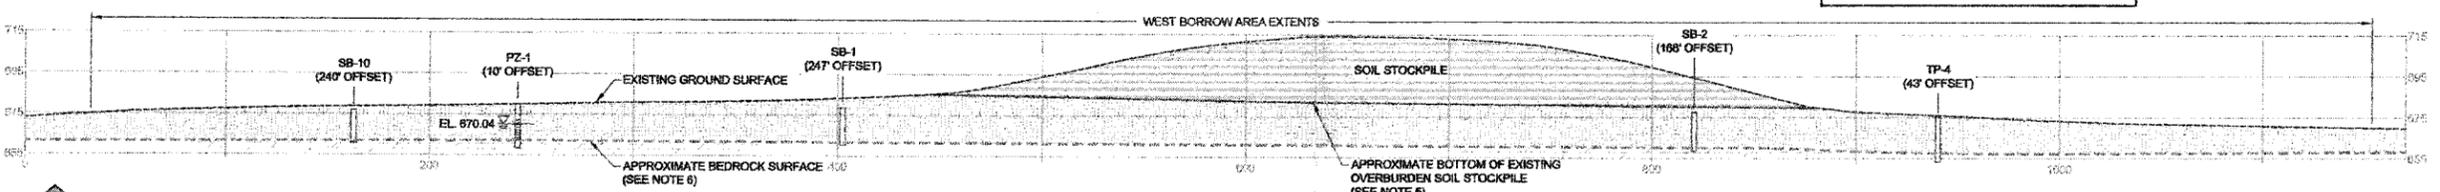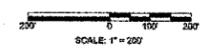

2 WEST BORROW AREA CROSS-SECTION
SCALE: 1" = 40'

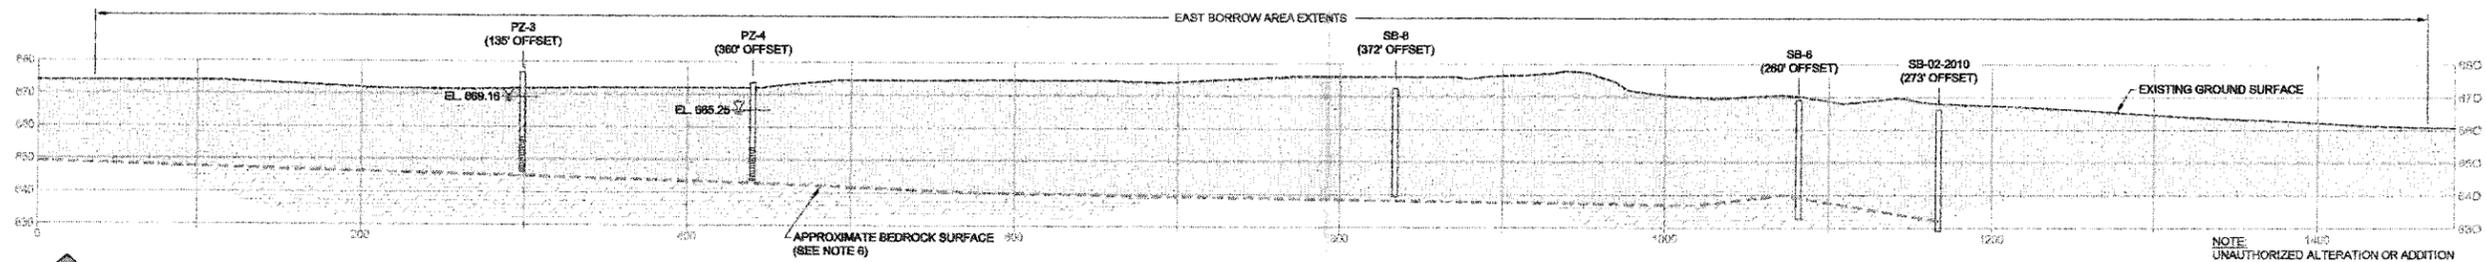

3 EAST BORROW AREA CROSS-SECTION
HORIZONTAL SCALE: 1" = 50'
VERTICAL SCALE: 1" = 25'

McMahon & Mann
Consulting Engineers, P.C.
1000 ROUTE 43E
RUFFALO, NY 14214
TEL: (716) 834-8800
FAX: (716) 834-8804


REDUCED

REV 1	REV 2	REV 3	REV 4	REV 5	REV 6
-------	-------	-------	-------	-------	-------

**MILL SEAT FACILITY
PROPOSED BORROW AREA - DSEIS
EXISTING CONDITIONS PLAN**
NEW YORK
MONROE COUNTY

DRAWN BY: C.R.G.
DESIGNED BY: A.J.N.
CHECKED BY: M.J.M.
SCALE: AS NOTED
DATE: JANUARY 2011
JOB NO: 08-015
FIGURE: 2-1
DWG. NO: 08015-050
REVISION NUMBER: 0

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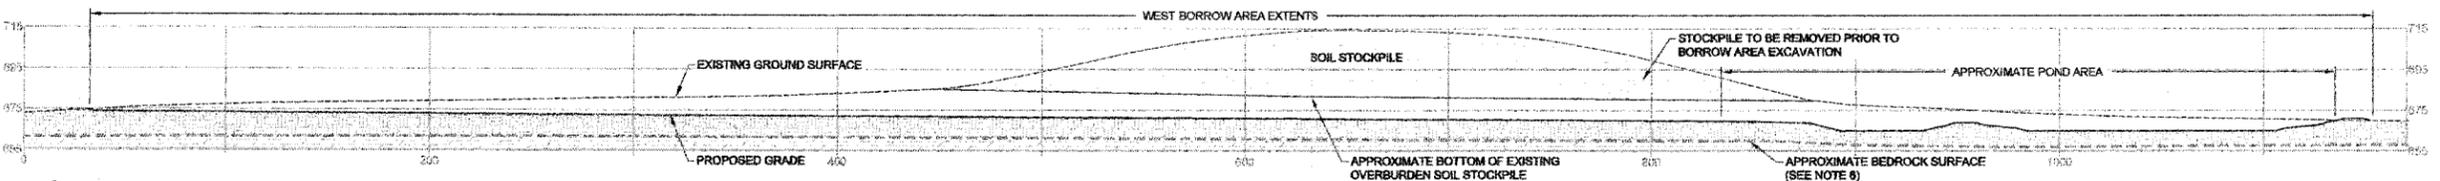


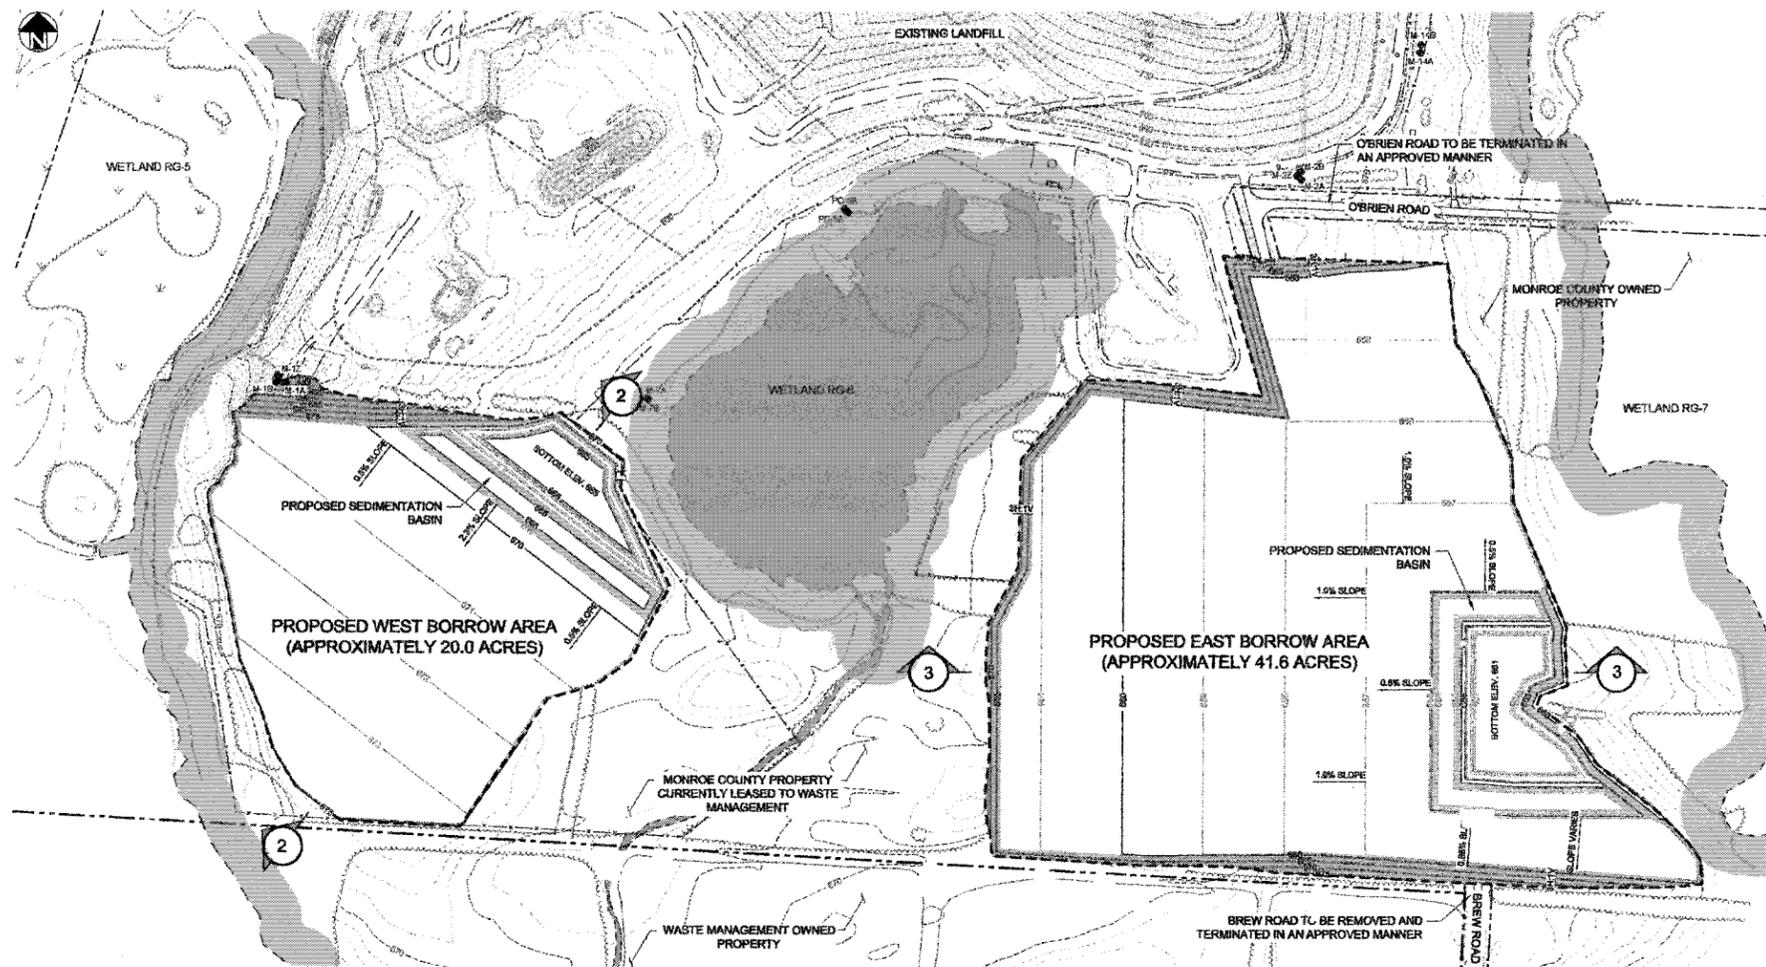LEGEND


- EXISTING GROUND CONTOURS (SEE NOTE 1)
- PROPOSED BORROW AREA CONTOURS
- EXISTING ROAD
- WASTE MANAGEMENT PROPERTY LINE (SEE NOTE 2)
- MONROE COUNTY PROPERTY LINE (SEE NOTE 2)
- EXISTING TREE LINE
- EXISTING FENCE LINE
- EXISTING WATER BOUNDARY
- PROPOSED BORROW AREA LIMITS
- LANDFILL STAGE LIMITS
- 100' WETLAND BUFFER (SEE NOTE 3)
- DELINEATED WETLANDS (SEE NOTE 3)
- MONITORING WELL LOCATION AND DESIGNATION (SEE NOTE 4)

- NOTES:**
1. Existing site topography and features are based on aerial photography dated July 2, 2006 compiled by Aero-Metric.
 2. Property lines were provided by Goldor Associates from drawing file X07389309A-Property Line and by Passero Associates from drawing file 200765103baBovoc.
 3. Wetland boundaries and buffers are based on Barton & Logsdon, P.C. Wetland Delineation Map dated August 12, 2009.
 4. Groundwater monitoring well locations are based on information presented on Figure 3 of the Hydrogeologic Investigation Report prepared by AMEC Geomatrix dated January 2011.
 5. Approximate bottom of existing stockpiles provided by Goldor Associates.
 6. Approximate existing bedrock surface is based on information presented on Figure 11 of the Hydrogeologic Investigation Report prepared by AMEC Geomatrix dated January 2011.

1 RECLAMATION PLAN
SCALE: 1" = 200'



2 WEST BORROW AREA CROSS-SECTION
SCALE: 1" = 40'

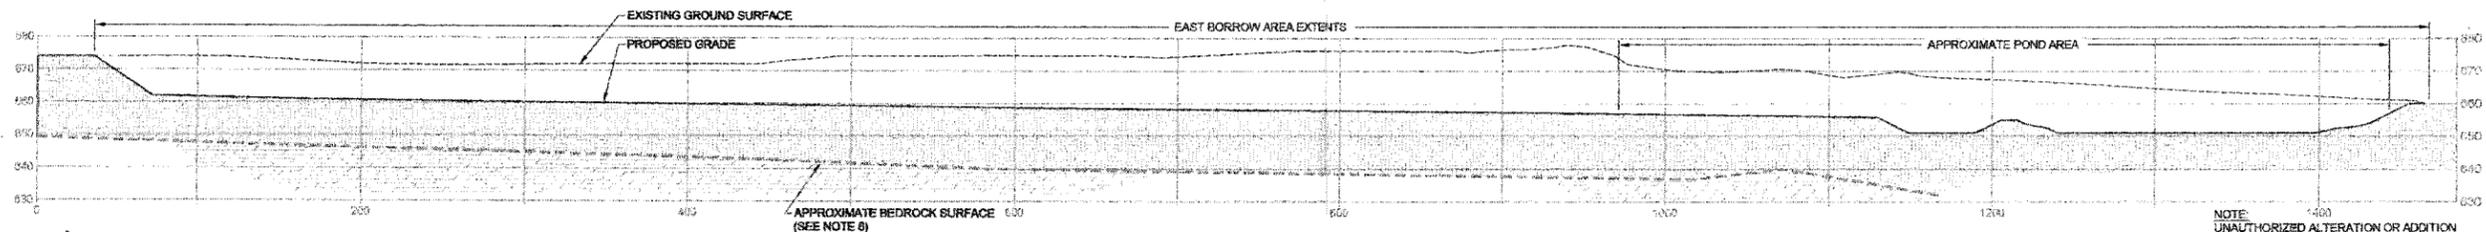

3 EAST BORROW AREA CROSS-SECTION
HORIZONTAL SCALE: 1" = 50'
VERTICAL SCALE: 1" = 25'

NOTE:
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Consulting Engineers P.C.
300 MAIN STREET, SUITE 202
BUFFALO, NY 14214
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FAX: (716) 834-8934


REDUCED

**MILL SEAT FACILITY
PROPOSED SOIL BORROW AREA - DSEIS
PROPOSED SITE PLAN**

NEW YORK
MONROE COUNTY

REV 1
REV 2
REV 3
REV 4
REV 5
REV 6

DRAWN BY: C.R.G.
DESIGNED BY: A.J.N.
CHECKED BY: M.J.M.
SCALE: AS NOTED
DATE: JANUARY 2011
JOB NO. 08-015
FIGURE 2-2
DWG. NO. 08015-047
REVISION NUMBER - 0

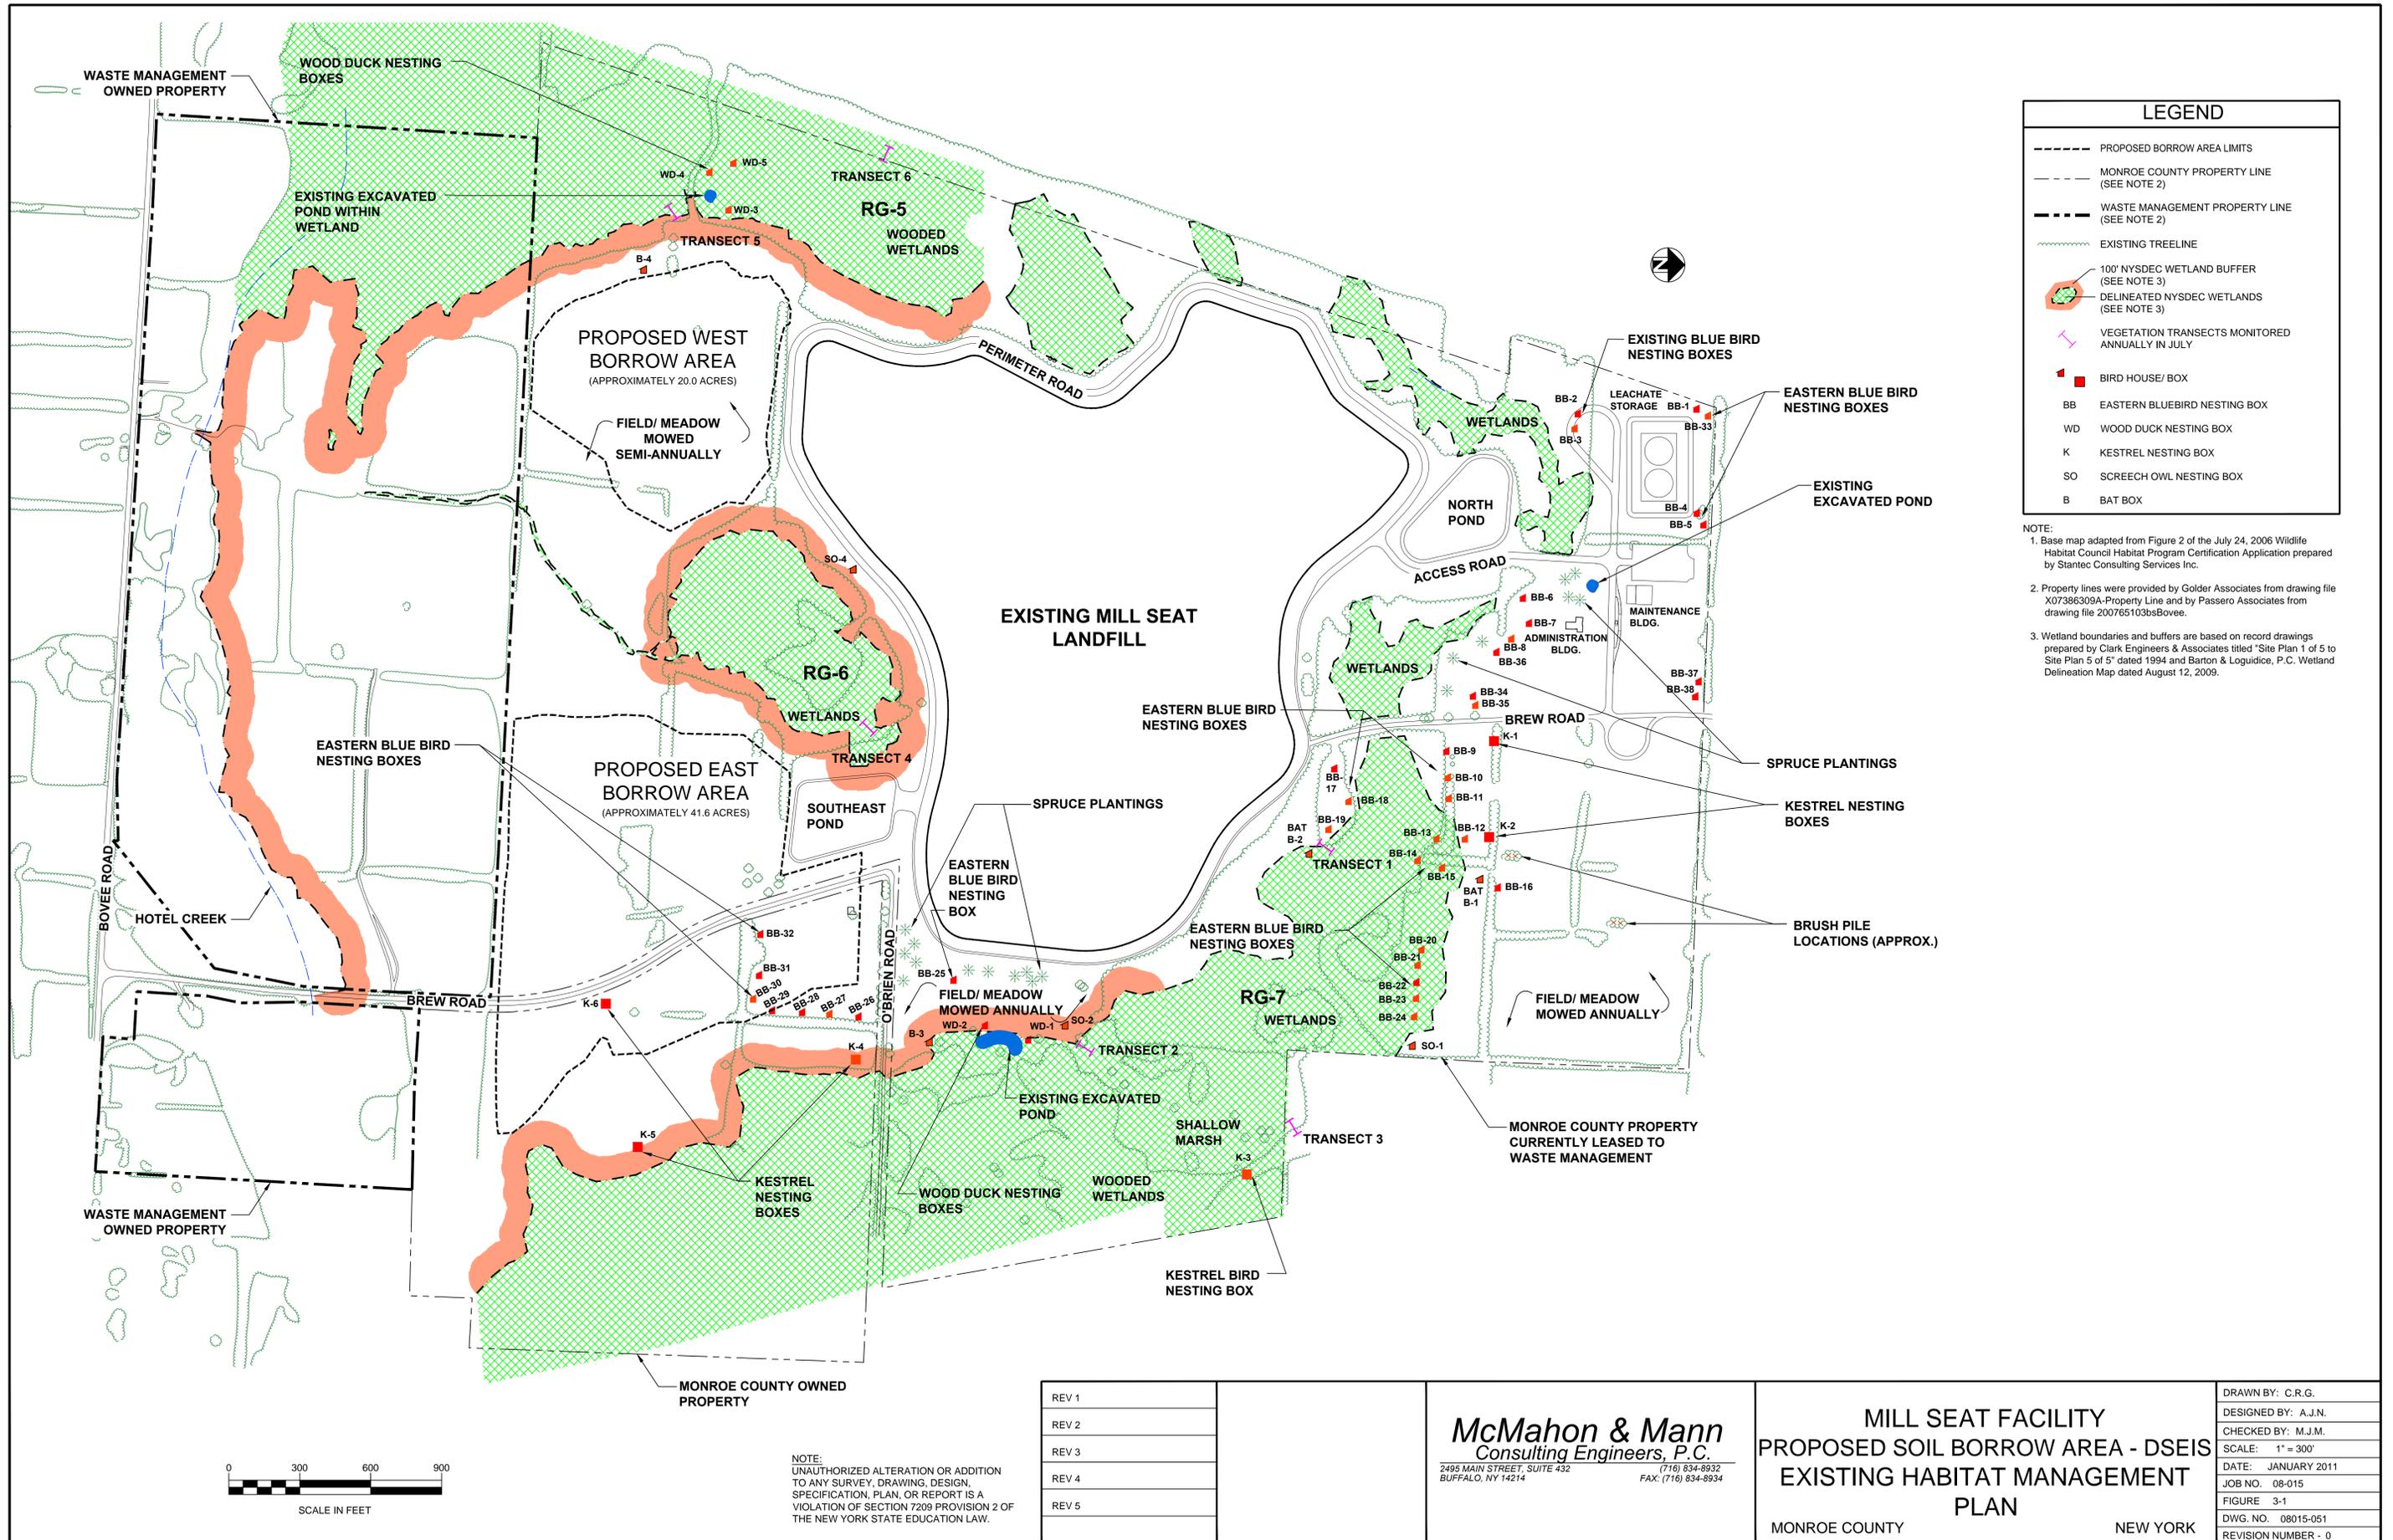

LEGEND

- PROPOSED BORROW AREA LIMITS
- - - MONROE COUNTY PROPERTY LINE (SEE NOTE 2)
- WASTE MANAGEMENT PROPERTY LINE (SEE NOTE 2)
- EXISTING TREELINE
- 100' NYSDEC WETLAND BUFFER (SEE NOTE 3)
- DELINEATED NYSDEC WETLANDS (SEE NOTE 3)
- VEGETATION TRANSECTS MONITORED ANNUALLY IN JULY
- BIRD HOUSE/ BOX
- BB EASTERN BLUEBIRD NESTING BOX
- WD WOOD DUCK NESTING BOX
- K KESTREL NESTING BOX
- SO SCREECH OWL NESTING BOX
- B BAT BOX

NOTE:
 1. Base map adapted from Figure 2 of the July 24, 2006 Wildlife Habitat Council Habitat Program Certification Application prepared by Stantec Consulting Services Inc.
 2. Property lines were provided by Golder Associates from drawing file X07386309A-Property Line and by Passero Associates from drawing file 200765103bsBovee.
 3. Wetland boundaries and buffers are based on record drawings prepared by Clark Engineers & Associates titled "Site Plan 1 of 5 to Site Plan 5 of 5" dated 1994 and Barton & Loguidice, P.C. Wetland Delineation Map dated August 12, 2009.

REV 1
REV 2
REV 3
REV 4
REV 5


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MILL SEAT FACILITY
PROPOSED SOIL BORROW AREA - DSEIS
EXISTING HABITAT MANAGEMENT
PLAN
 MONROE COUNTY NEW YORK

DRAWN BY: C.R.G.
DESIGNED BY: A.J.N.
CHECKED BY: M.J.M.
SCALE: 1" = 300'
DATE: JANUARY 2011
JOB NO. 08-015
FIGURE 3-1
DWG. NO. 08015-051
REVISION NUMBER - 0

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TYPICAL NOISE LEVELS (dBA)


TYPICAL SOUND LEVELS	MILL SEAT FACILITY PROPOSED SOIL BORROW AREA DSEIS	McMahon & Mann Consulting Engineers, P.C.
DWG. NO. 08015-052	MONROE COUNTY	2495 MAIN STREET, SUITE 432 BUFFALO, NY 14214
FIGURE 4-1	NEW YORK	(716) 834-8932 FAX: (716) 834-8934

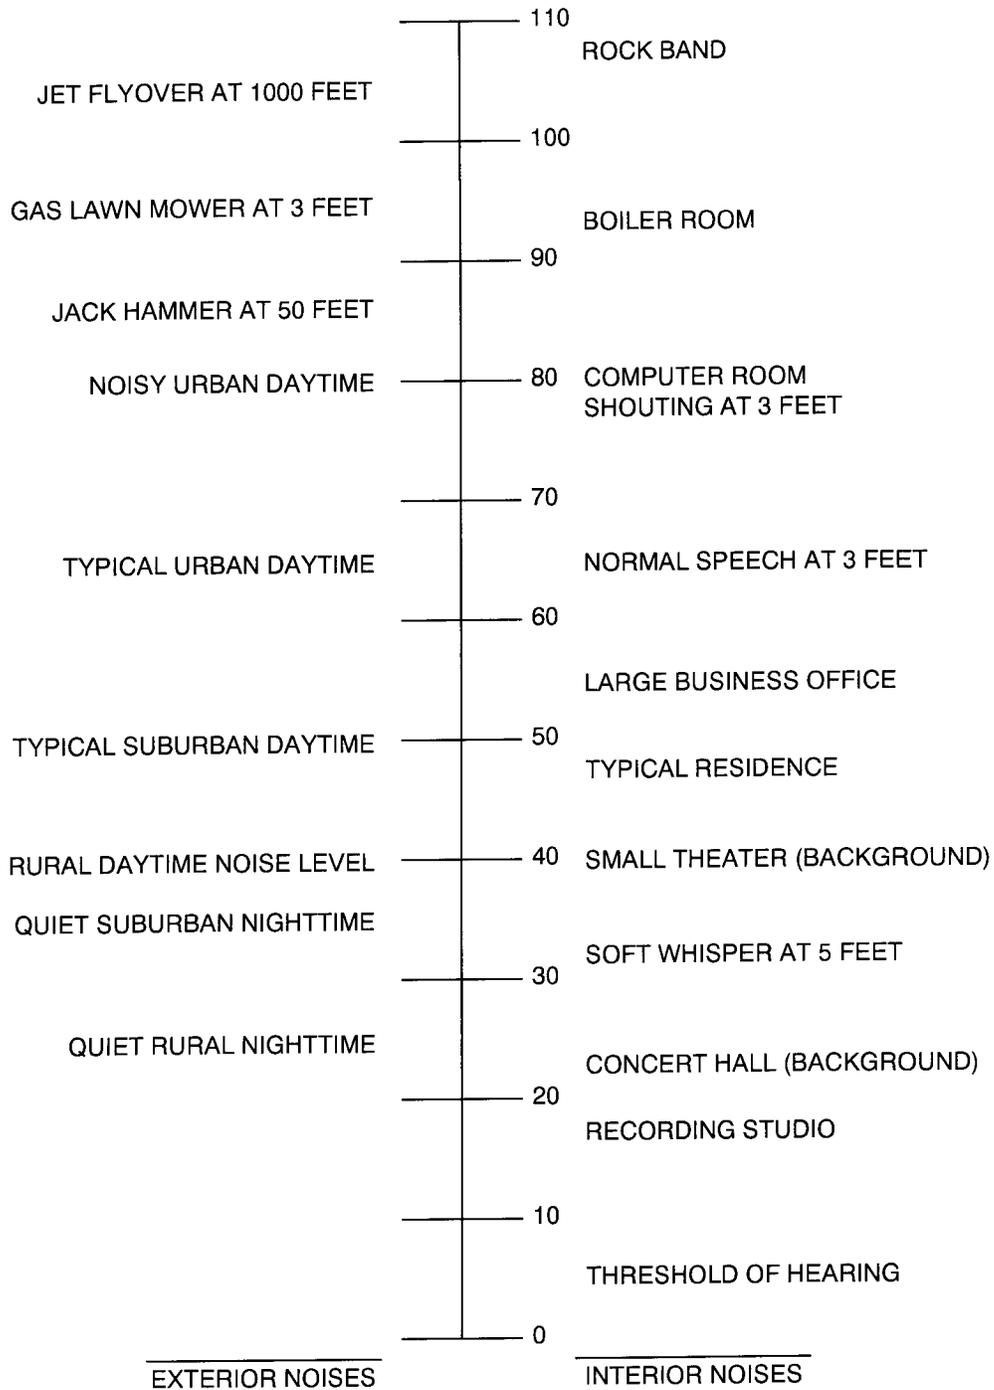

LEGEND	
①	SOUND READING LOCATION AND DESIGNATION (SEE NOTE 4)
50	SOUND READING MEASUREMENT (dBA) (SEE NOTE 4)
*	RECEPTOR LOCATION
- - - -	PROPERTY LINE (SEE NOTE 2)
—	DELINEATED WETLAND LIMIT (SEE NOTE 3)
- - - -	PROPOSED BORROW AREA LIMIT
- - - -	EXISTING LANDFILL LIMITS

NOTE:
 1. Base map aerial photo completed by Air Survey Corp. dated July 2, 2008.
 2. Property lines were provided by Golder Associates from drawing file X07386309A-Property Line and by Passero Associates from drawing file 200765103bsBovee.
 3. Wetland boundaries are based on Barton & Loguidice, P.C. Wetland Delineation Map dated August 12, 2009.
 4. Field observations and measurements based on site visit dated February 19, 2010.

1
4-2 NOISE IMPACT OBSERVATION LOCATIONS
SCALE: 1" = 800'

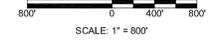

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REV 1
REV 2
REV 3
REV 4
REV 5

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MILL SEAT FACILITY
 PROPOSED SOIL BORROW AREA - DSEIS
 NOISE IMPACT OBSERVATION
 LOCATIONS
 MONROE COUNTY NEW YORK


DRAWN BY: C.R.G.
DESIGNED BY: A.J.N.
CHECKED BY: M.J.M.
SCALE: AS SHOWN
DATE: JANUARY 2011
JOB NO. 08-015
FIGURE 4-2
DWG. NO. 08015-043
REVISION NUMBER - 0



LEGEND	
	PHOTO LOCATION, DIRECTION AND DESIGNATION (SEE NOTE 5)
	PROPERTY LINE (SEE NOTE 2)
	DELINEATED WETLAND LIMIT (SEE NOTE 3)
	PROPOSED BORROW AREA LIMIT
	EXISTING LANDFILL LIMITS
	PROJECT LIMITS (SEE NOTE 4)
	0.5 MILE RADIUS
	1.0 MILE RADIUS

- NOTE:
1. Base map aerial photo completed by Air Survey Corp. dated July 2, 2008.
 2. Property lines were provided by Golder Associates from drawing file X07386309A-Property Line and by Passero Associates from drawing file 200765103bsBovee.
 3. Wetland boundaries are based on Barton & Loguidice, P.C. Wetland Delineation Map dated August 12, 2009.
 4. Project limits assumed circular with the circle diameter based on the limits of the West and East Borrow Areas.
 5. Field observations and photos based on site visit dated February 19, 2010.

1 MILL SEAT FACILITY AERIAL PHOTO
4-3 SCALE: 1" = 800'

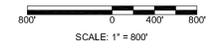


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REV 2	
REV 3	
REV 4	
REV 5	

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BUFFALO, NY 14214 FAX: (716) 834-8934

MILL SEAT FACILITY
PROPOSED SOIL BORROW AREA - DSEIS
VISUAL IMPACT OBSERVATION
LOCATIONS
AERIAL PHOTO PLAN
MONROE COUNTY NEW YORK

DRAWN BY: C.R.G.
DESIGNED BY: S.W.L.
CHECKED BY: A.J.N.
SCALE: 1" = 800'
DATE: JANUARY 2011
JOB NO. 08-015
FIGURE 4-3
DWG. NO. 08015-040
REVISION NUMBER - 0

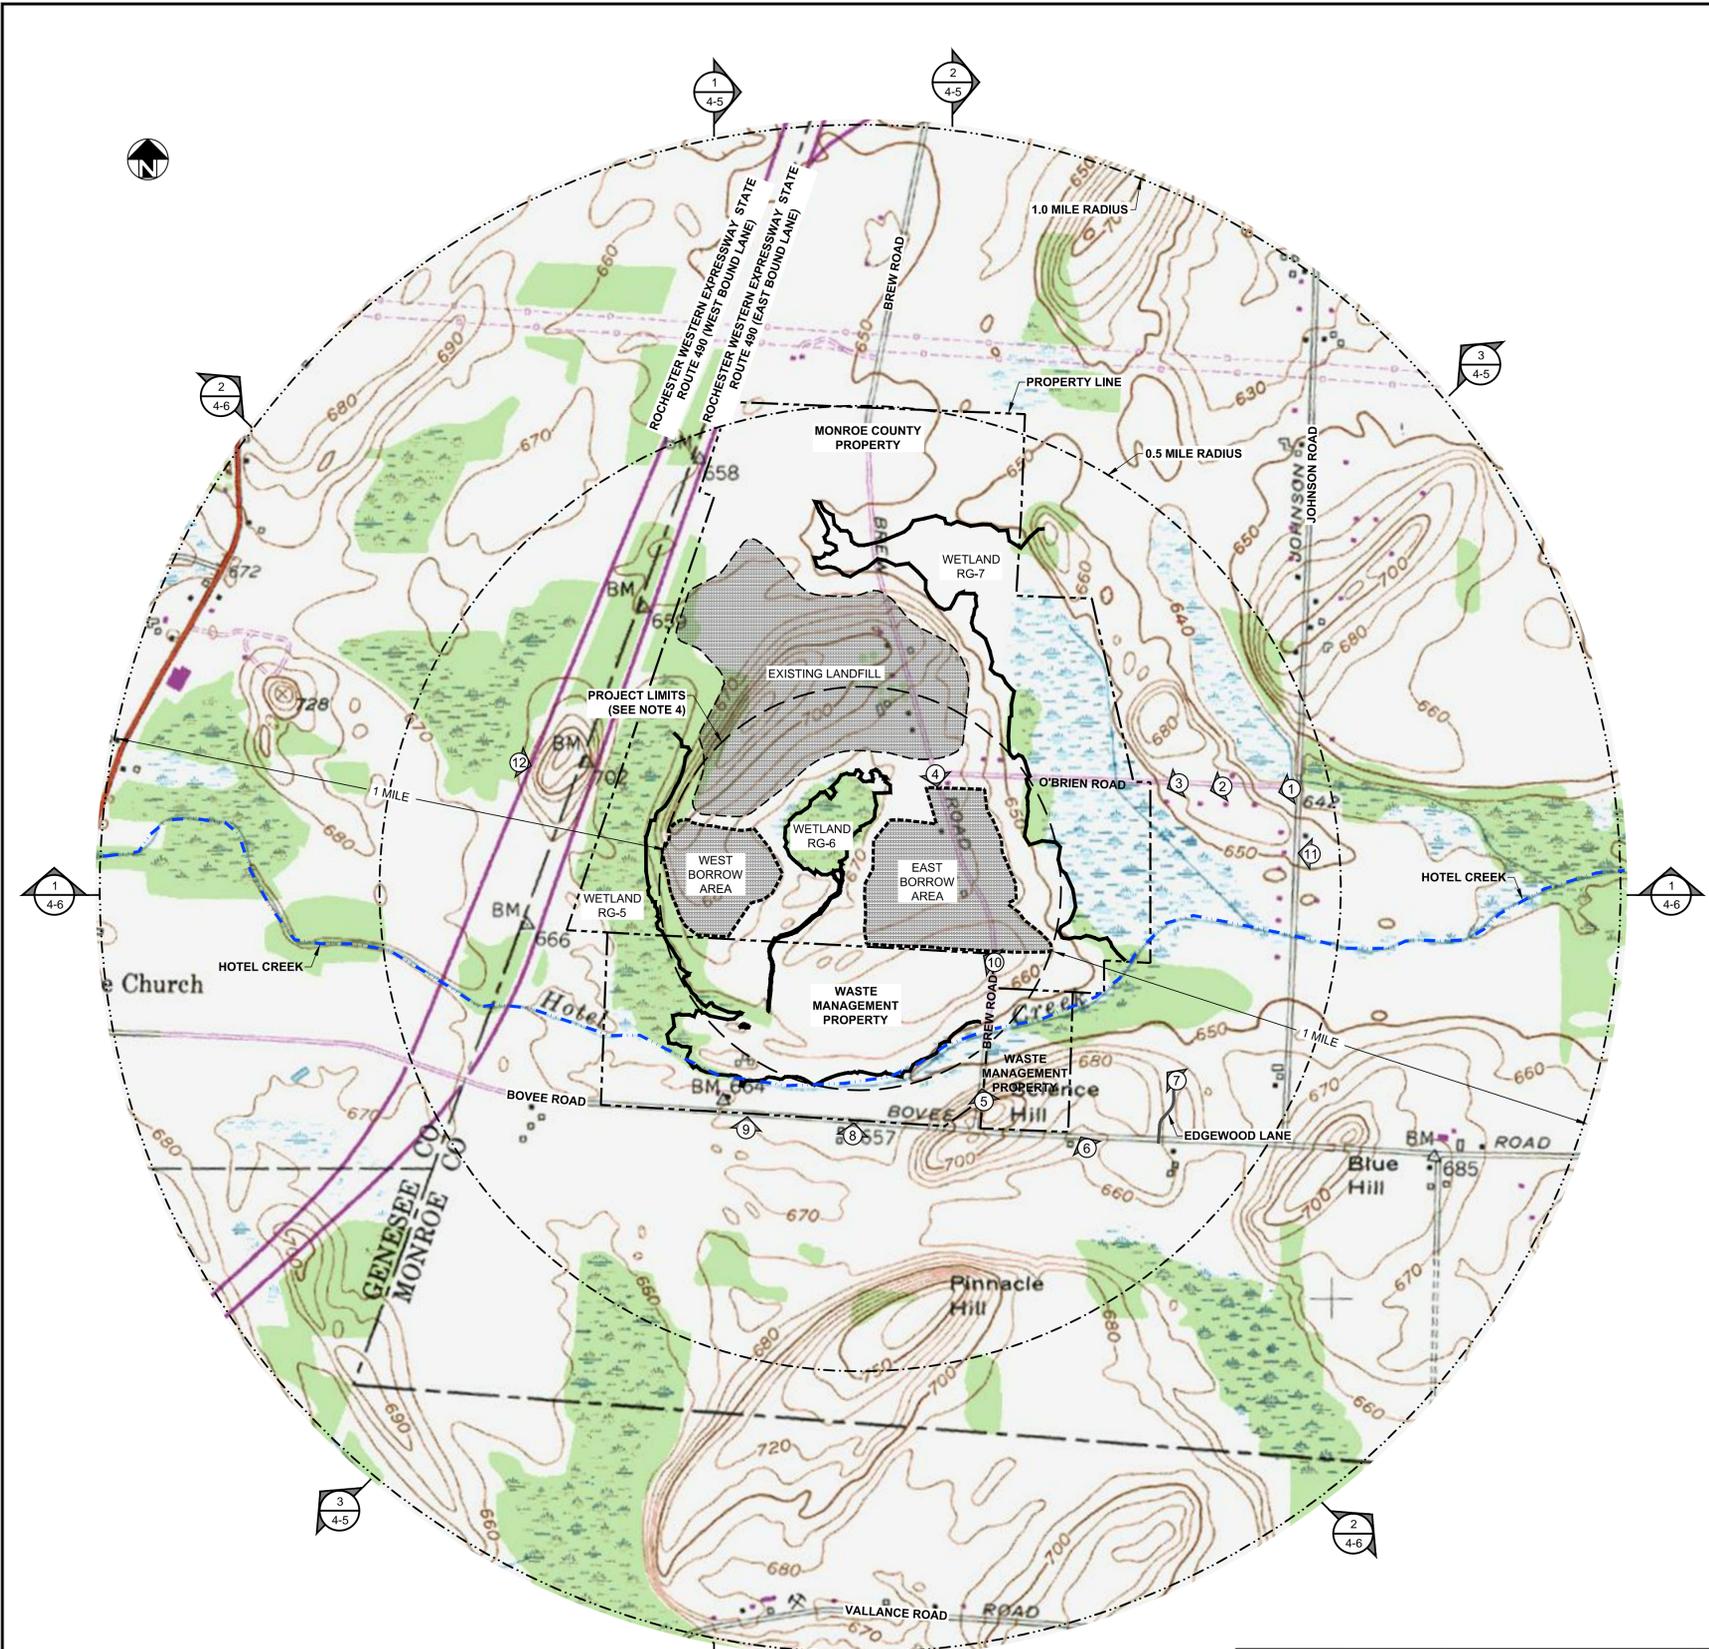

LEGEND

- PHOTO LOCATION, DIRECTION AND DESIGNATION (SEE NOTE 5)
- PROPERTY LINE (SEE NOTE 2)
- DELINEATED WETLAND LIMIT (SEE NOTE 3)
- PROJECT LIMITS (SEE NOTE 4)
- 0.5 MILE RADIUS
- 1.0 MILE RADIUS
- PROPOSED BORROW AREA LIMIT
- EXISTING LANDFILL LIMITS

NOTE:

1. Base map adapted from 7.5 minute series USGS quadrangle map of Churchville, N.Y., dated 1950.
2. Property lines were provided by Golder Associates from drawing file X07386309A-Property Line and by Passero Associates from drawing file 200765103bsBovee.
3. Wetland boundaries are based on Barton & Loguidice, P.C. Wetland Delineation Map dated August 12, 2009.
4. Project limits assumed circular with the circle diameter based on the limits of the West and East Borrow Areas.
5. Field observations and photos based on site visit dated February 19, 2010.

1
4-4 MILL SEAT FACILITY TOPOGRAPHIC MAP
SCALE: 1" = 800'




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REV 2	
REV 3	
REV 4	
REV 5	


McMahon & Mann
Consulting Engineers, P.C.
2495 MAIN STREET, SUITE 432 (716) 834-8932
BUFFALO, NY 14214 FAX: (716) 834-8934

MILL SEAT FACILITY
PROPOSED SOIL BORROW AREA - DSEIS
VISUAL IMPACT OBSERVATION
LOCATIONS
TOPOGRAPHIC PLAN
MONROE COUNTY NEW YORK


DRAWN BY: C.R.G.
DESIGNED BY: S.W.L.
CHECKED BY: A.J.N.
SCALE: 1" = 800'
DATE: JANUARY 2011
JOB NO. 08-015
FIGURE 4-4
DWG. NO. 08015-041a
REVISION NUMBER - 0

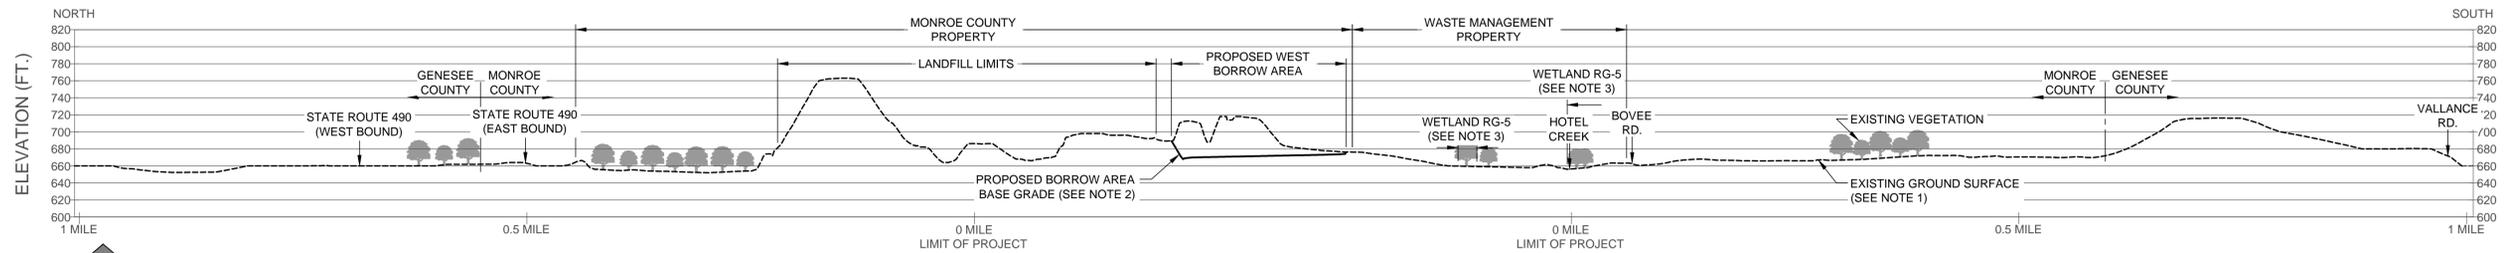

1
4-5
NORTH TO SOUTH SECTION - 1
HORIZONTAL SCALE: 1" = 500'
VERTICAL SCALE: 1" = 100'

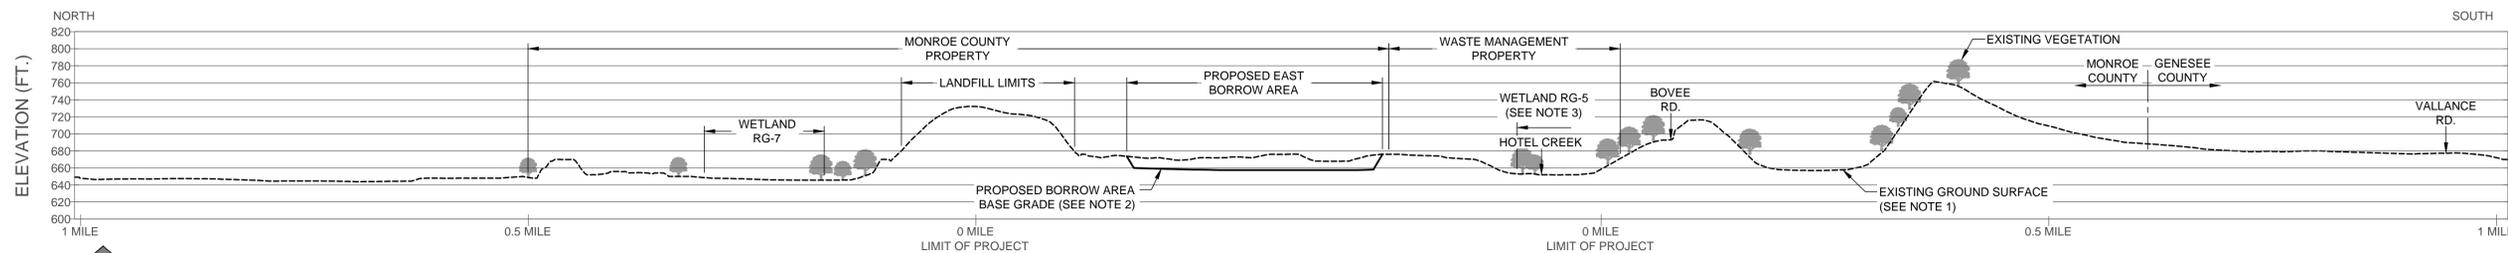

2
4-5
NORTH TO SOUTH SECTION - 2
HORIZONTAL SCALE: 1" = 500'
VERTICAL SCALE: 1" = 100'

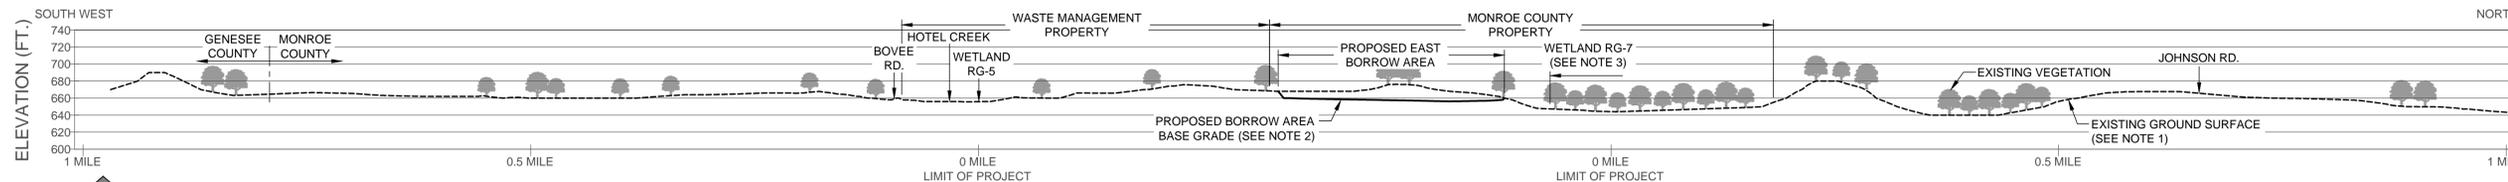

3
4-5
SOUTH WEST TO NORTH EAST
HORIZONTAL SCALE: 1" = 500'
VERTICAL SCALE: 1" = 100'

LEGEND	
-----	EXISTING GROUND SURFACE (SEE NOTE 1)
_____	PROPOSED BORROW AREA GRADES (SEE NOTE 2)

- NOTES:
- Existing ground contours shown within Monroe County and Waste Management property are based on aerial photography dated June 16, 2009 compiled by Aero-Metric. Existing contours shown outside of property lines are based on 7.5 minute Series USGS Quadrangle map of Churchville, NY dated 1950.
 - Proposed borrow area grades based on Figure 4 of the Borrow Area Use Plan, prepared by McMahon & Mann Consulting Engineers, P.C. dated March 2010.
 - Wetlands only shown on Monroe County and Waste Management property. Mapping was not completed outside of these limits.





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REV 3
REV 4
REV 5

McMahon & Mann
Consulting Engineers, P.C.
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(716) 834-8932 FAX: (716) 834-8934

MILL SEAT FACILITY
PROPOSED SOIL BORROW AREA-DSEIS
VISUAL IMPACT OBSERVATION
SECTIONS
MONROE COUNTY NEW YORK

DRAWN BY: C.R.G.
DESIGNED BY: S.W.L.
CHECKED BY: A.J.N.
SCALE: AS SHOWN
DATE: JANUARY 2011
JOB NO. 08-015
FIGURE 4-5
DWG. NO. 08015-041b
REVISION NUMBER - 0

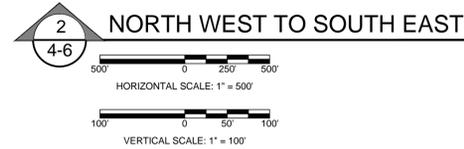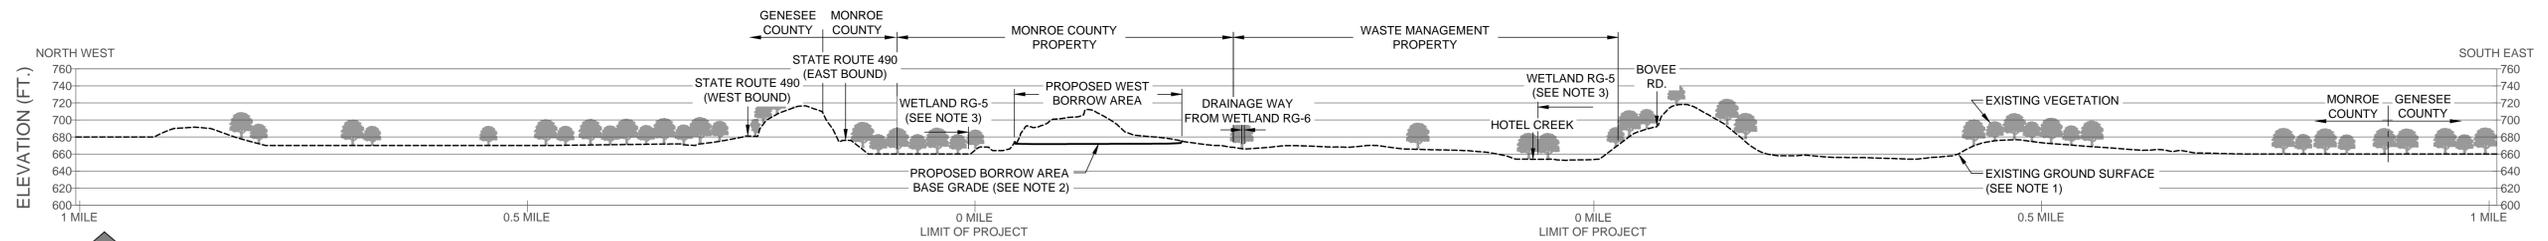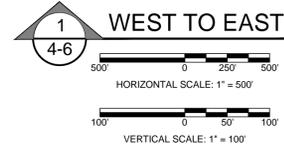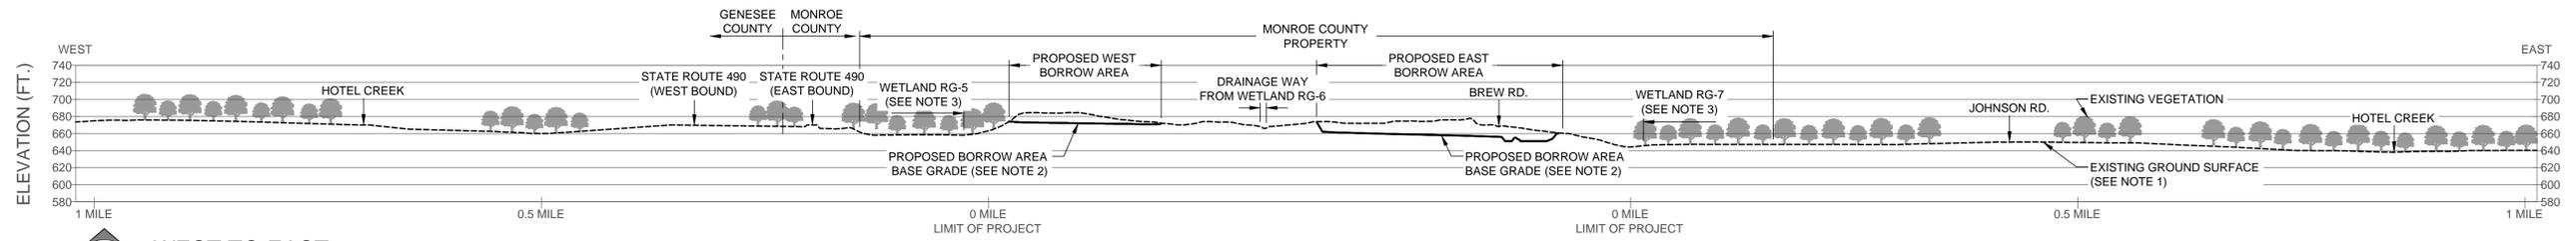

LEGEND	
-----	EXISTING GROUND SURFACE (SEE NOTE 1)
_____	PROPOSED BORROW AREA GRADES (SEE NOTE 2)

- NOTES:
- Existing ground contours shown within Monroe County and Waste Management property are based on aerial photography dated June 16, 2009 compiled by Aero-Metric. Existing contours shown outside of property lines are based on 7.5 minute Series USGS Quadrangle map of Churchville, NY dated 1950.
 - Proposed borrow area grades based on Figure 4 of the Borrow Area Use Plan, prepared by McMahon & Mann Consulting Engineers, P.C. dated March 2010.
 - Wetlands only shown on Monroe County and Waste Management property. Mapping was not completed outside of these limits.

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REV 4
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Consulting Engineers, P.C.
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BUFFALO, NY 14214 FAX: (716) 834-8934


MILL SEAT FACILITY
PROPOSED SOIL BORROW AREA- DSEIS
VISUAL IMPACT OBSERVATION
SECTIONS
MONROE COUNTY NEW YORK

DRAWN BY: C.R.G.
DESIGNED BY: S.W.L.
CHECKED BY: A.J.N.
SCALE: AS SHOWN
DATE: JANUARY 2011
JOB NO. 08-015
FIGURE 4-6
DWG. NO. 08015-041c
REVISION NUMBER - 0

LEGEND

- PROPERTY LINE (SEE NOTE 2)
- ADJACENT PROPERTY LINES (SEE NOTE 3)
- - - EXISTING LANDFILL LIMITS
- ▨ CURRENTLY PROPOSED BORROW AREA LIMITS
- ▨ POTENTIAL ALTERNATIVE SITE LIMITS
- APPROXIMATE WETLAND LIMITS (SEE NOTES 3 & 4)

- NOTE:**
1. USGS map adapted from 7.5 minute series USGS quadrangle map of Churchville, N.Y. dated 1950.
 2. Facility property lines were provided by Golder Associates from drawing file X07386308A-Property Line and by Passero Associates from drawing file 200785103bsBovee.
 3. Delineated wetland boundaries adjacent to the facility are based on Barton & Loguidice, P.C. Wetland Delineation Map dated August 12, 2009.
 4. Property lines and wetland boundaries adjacent to potential borrow source areas are based upon GIS maps from the Monroe County Parcel Viewer website and the Genesee County Internet Mapping System.

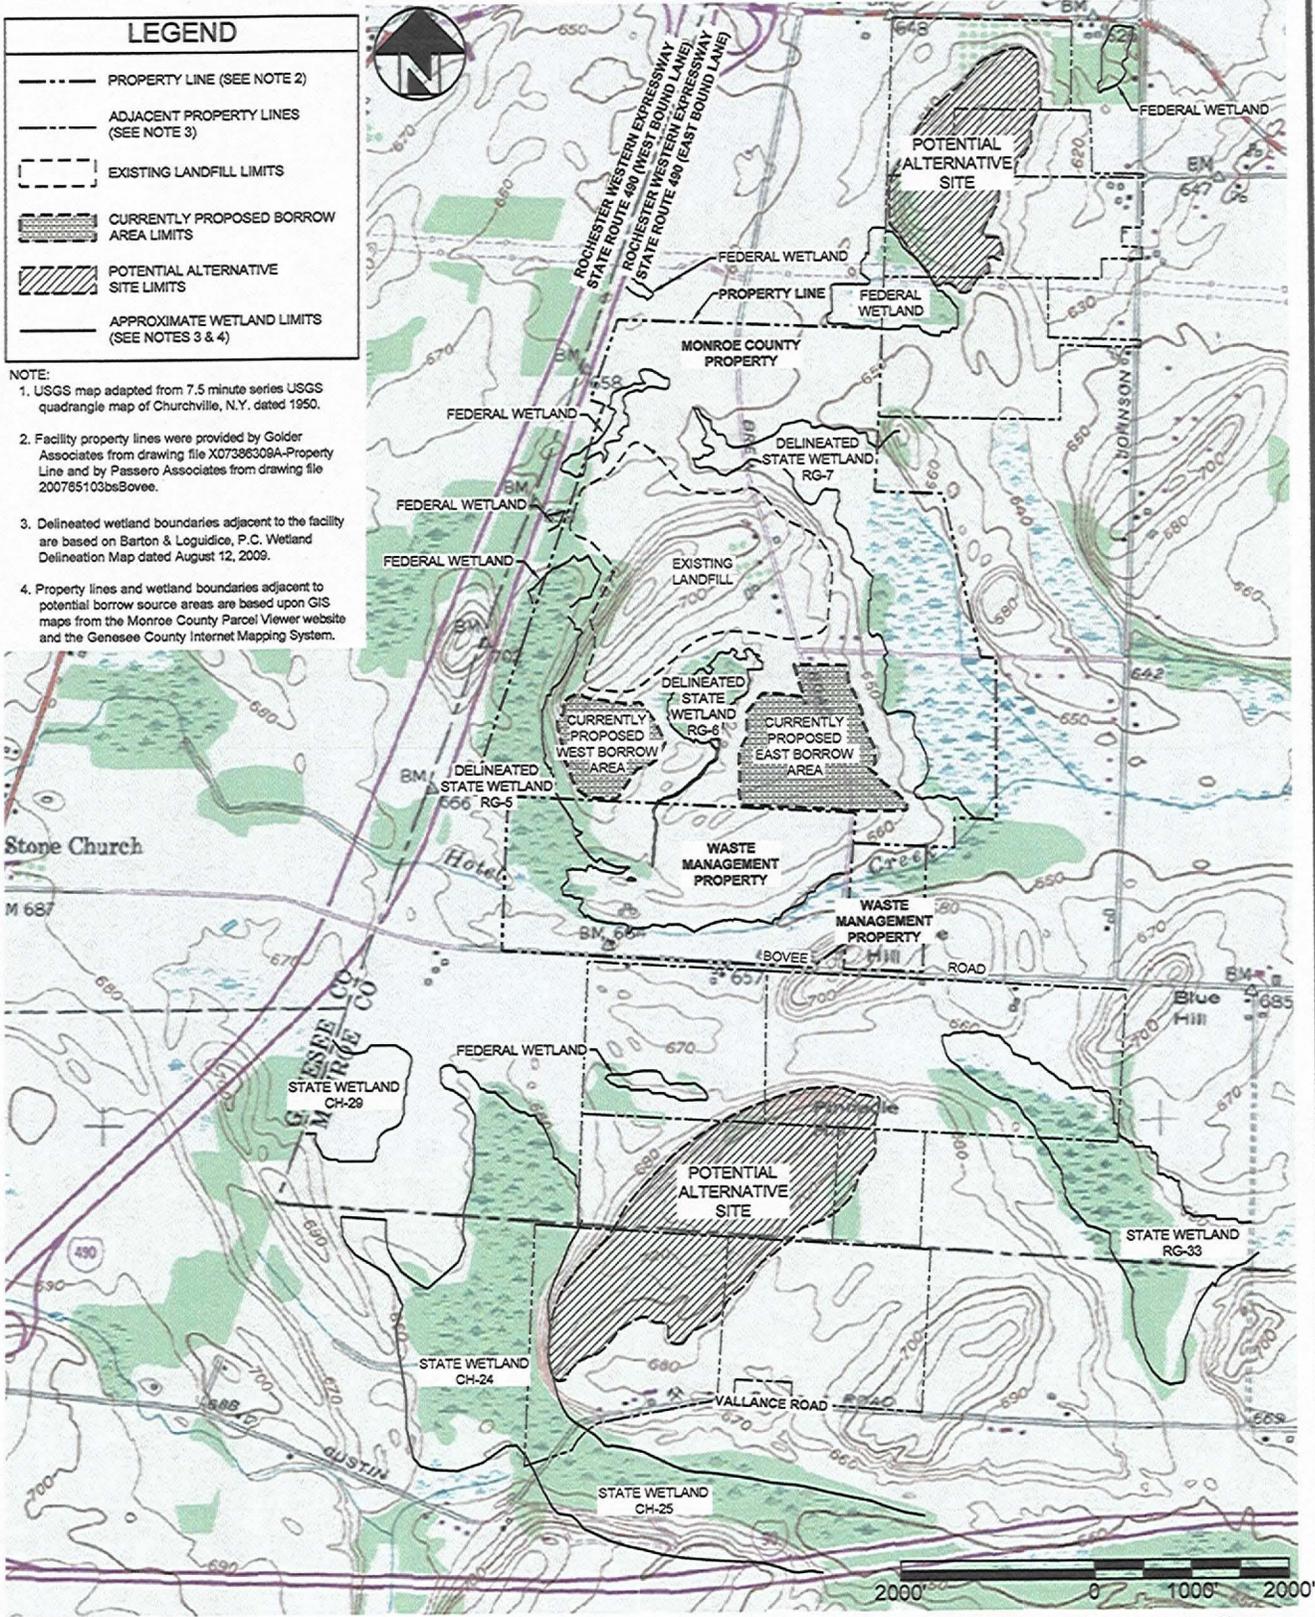

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MILL SEAT FACILITY
 PROPOSED SOIL BORROW AREA
 DSEIS
 MONROE COUNTY NEW YORK

ALTERNATIVE BORROW SITES
 DWG. NO. 08015-054
 FIGURE 6-1